

LOCATION MAP

U.S.G.S. POUGHKEEPSIE QUADRANGLE
SCALE: 1" = 2000'

GENERAL NOTES:

1. TOTAL AREA OF SUBJECT PARCEL: 10.7675 ACRES
2. PROPOSED NUMBER OF LOTS: 6
3. RECORD OWNER & APPLICANT:
DOUGLAS SMITH
PO BOX 452
MARBORO, NY 12542
4. TAX MAP IDENTIFICATION NUMBER: SECTION 103.1, BLOCK 4, LOT 47.13
5. DEED REFERENCE:
DEED LIBER 4627, PAGE 295
6. MAP REFERENCES:

A. A MAP ENTITLED, "FINAL MAP PREPARED FOR ROBERT YOUNG" BY BROOKS AND BROOKS, DATED NOVEMBER 11, 1954 AND FILED IN THE OFFICE OF THE ULSTER COUNTY CLERK ON DECEMBER 2, 1954 AS MAP NUMBER 10125.
7. A MAP ENTITLED, "MAP SHOWING UNGROUND HEIGHTS" DATED NOVEMBER 1954 AND FILED IN THE OFFICE OF THE ULSTER COUNTY CLERK ON SEPTEMBER 12, 1995 AS MAP NUMBER 1763.
8. THIS SURVEY IS SUBJECT TO THE FINDINGS OF AN UP TO DATE ABSTRACT OF TITLE.
9. SUBJECT TO ANY UNWRITTEN AND/OR WRITTEN LICENSES, EASEMENTS, RESTRICTIONS, AND/OR AGREEMENTS OF RECORD.
10. OFFSETS OR DIMENSIONS FROM THE PROPERTY LINES TO STRUCTURES OR IMPROVEMENTS ARE SHOWN FOR THE SPECIFIC PURPOSE OF INTERPRETATION OF COMPLIANCE WITH ZONING AND ARE NOT INTENDED TO MONUMENT THE PROPERTY LINES OR TO GUIDE THE ERECTION OF FENCES OR ANY OTHER IMPROVEMENTS TO THE LAND.
11. THE TOPOGRAPHY SHOWN HEREON WAS COMPILED BY ENGINEERING & SURVEYING PROPERTIES CO. FROM USGS 1:62,500 FLATTENED DIGITAL ELEVATION MODELS (DEMS) AS DERIVED FROM 2012 SOURCE LIDAR. TLM DEMS WERE PROVIDED BY NYS GIS GOV AND CORRESPOND TO ACTUAL ELEVATIONS TAKEN IN THE FIELD. CONTOURS ARE BASED ON NORTH AMERICAN VERTICAL DATUM OF 1988.
12. CERTIFICATIONS ON THIS BOUNDARY SURVEY MAP SIGNIFY THAT THE MAP WAS PREPARED IN ACCORDANCE WITH THE CURRENT EXISTING CODE OF PRACTICE FOR LAND SURVEYS ADOPTED BY THE NEW YORK STATE ASSOCIATION OF PROFESSIONAL LAND SURVEYORS, INC. THE INFORMATION IS RELIED UPON BY THE PERSONS FOR WHOM THE BOUNDARY SURVEY MAP IS PREPARED, TO THE TITLE COMPANY, TO THE GOVERNMENTAL AGENCY, AND TO THE LENDING INSTITUTION LISTED ON THIS BOUNDARY SURVEY MAP.
13. CERTIFICATIONS HEREON ARE NOT TRANSFERABLE.
14. ISSUING OF A NEW TITLE POLICY OR REDATING OF AN EXISTING POLICY REFERENCING THIS SURVEY WITHOUT THE BENEFIT OF AN UPDATE OF THIS SURVEY BY ENGINEERING & SURVEYING PROPERTIES, P.C. SHALL TERMINATE ANY LIABILITY EXPRESSED OR IMPLIED HEREON.
15. UNAUTHORIZED COPIES MAY CONTAIN FRAUDULENT, INCORRECT, ERRONEOUS, OR MISLEADING INFORMATION OR OMIT IMPORTANT AND NECESSARY INFORMATION. IT IS NOT RELY ON UNAUTHORIZED COPIES OF THE SEAL, SIGNATURE, AND CERTIFICATION ARE HEREBY REVOKED OR OTHERWISE VOID ON ALL UNAUTHORIZED COPIES. ALL ORIGINAL DOCUMENTS BEAR AN ORIGINAL IMPRESSION AND INK SIGNATURE.
16. ALL UNDERGROUND UTILITIES AND/OR IMPROVEMENTS OR THE ENCROACHMENT OF SUCH IMPROVEMENTS ARE NOT ALWAYS KNOWN AND OFTEN MUST BE ESTIMATED. IF THE ENCROACHMENT OF SUCH UNDERGROUND IMPROVEMENTS EXIST OR ARE SHOWN HEREON, THE ENCROACHMENTS OF SUCH UNDERGROUND UTILITIES AND/OR IMPROVEMENTS ARE NOT COVERED BY THIS CERTIFICATE.
17. SUBJECT TO A DRAINAGE EASEMENT OVER THE LANDS OF QUIMBY IN FAVOR OF DEAN PAUL PETERSON, INC. AS RECORDED IN DEED LIBER 5540 OF THE ULSTER COUNTY CLERK ON APRIL 3, 2013 IN DEED LIBER 5540, PAGE 89.
18. THERE SHALL BE NO FURTHER SUBDIVISION OF ANY LOT PERMITTED UNDER CURRENT ZONING.

LEGEND

	PROPERTY LINE
	ADJOINING PROPERTY LINE
	PROPOSED LOT LINE
	CONTOUR LINE
	INDEX CONTOUR
	EXIST EASEMENT
	PROPOSED EASEMENT
	BUILDING SETBACK LINE
	EDGE OF PAVEMENT
	EDGE OF GRAVEL
	ZONING DISTRICT LINE
	WATER DISTRICT BOUNDARY
	STONEWALL
	OVERHEAD WIRE
	HYDRANT
	WOODEN UTILITY POLE
	METAL UTILITY POLE
	CUT-OFF UTILITY POLE
	GUY ANCHOR
	PIPE FOUND
	REBAR FOUND
	CAPPED REBAR TO BE SET
	WELL CASING

BULK REQUIREMENTS

TOWN OF MARLBOROUGH
ZONING DISTRICT R-1

MINIMUM BUILDING REQUIREMENTS	REQUIRED	PROVIDED
LOT AREA	43,560 SF	> 43,560 SF
LOT WIDTH	150 FEET	> 150 FEET
LOT DEPTH	200 FEET	> 200 FEET
FRONT YARD	35 FEET	> 35 FEET
REAR YARD	35 FEET	> 35 FEET
SIDE YARD (ONE/BOTH)	35/70 FEET	> 35/70 FEET
MAXIMUM ALLOWABLE		
BUILDING HEIGHT	2 1/2 STORIES / 35 FT	< 35 FT
BUILDING COVERAGE	20 %	< 20 %

RECORD OWNER'S CONSENT NOTE:

THE UNDERSIGNED OWNERS OF THE PROPERTY HEREON STATE THAT THEY ARE FAMILIAR WITH THIS PLAN, ITS CONTENTS AND ITS LEGENDS AND HEREBY CONSENT TO ALL SAID TERMS AND CONDITIONS AS STATED HEREON AND TO THE FILING OF THIS PLAN IN THE OFFICE OF THE CLERK OF THE COUNTY OF ULSTER, IF SO REQUIRED.

RECORD OWNER'S SIGNATURE

DOUGLAS SMITH
PO BOX 452
MARLBORO, NY 12542

ULSTER COUNTY DEPARTMENT
OF HEALTH APPROVAL BOX


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DRAWING STATUS		ISSUE DATE: 02/05/19	
THIS SHEET IS PART OF THE PLAN SET ISSUED FOR		SHEET NUMBER	
<input type="checkbox"/> CONCEPT APPROVAL	N/A	OF	N/A
<input checked="" type="checkbox"/> PLANNING BOARD APPROVAL	1	OF	6
<input checked="" type="checkbox"/> UCDOH REALTY SUBDIVISION APPROVAL	1	OF	6
<input checked="" type="checkbox"/> UCDOH WATERMAIN EXTENSION APPROVAL	N/A	OF	N/A
<input type="checkbox"/> NYSDEC APPROVAL	N/A	OF	N/A
<input type="checkbox"/> NYSDOT APPROVAL	N/A	OF	N/A
<input type="checkbox"/> OTHER	N/A	OF	N/A
<input type="checkbox"/> FOR PID	N/A	OF	N/A
<input type="checkbox"/> FOR CONSTRUCTION	N/A	OF	N/A
<p>THIS PLAN SET HAS BEEN ISSUED SPECIFICALLY FOR THE APPROVAL OR ACTION NOTED ABOVE AND SHALL NOT BE USED FOR ANY OTHER PURPOSE.</p> <p>THIS SHEET SHALL BE CONSIDERED INVALID UNLESS ACCOMPANIED BY ALL SHEETS OF THE DENOTED PLAN SET(S).</p>			

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APPLICATION OF THE
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LAND SURVEYOR'S
EMBOSSED SEAL SHOULD
BE ASSUMED TO BE AN
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UNAUTHORIZED
ALTERATION OR ADDITION
TO A SURVEY MAP BEARING
A LICENSED PROFESSIONAL
LAND SURVEYOR'S SEAL IS
A VIOLATION OF SECTION
7209, SUB-DIVISION 2, OF
THE NEW YORK STATE
EDUCATION LAW.

BRIAN D. BABCOCK, L.S.
NEW YORK STATE LICENSE # 050830



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REALTY SUBDIVISION

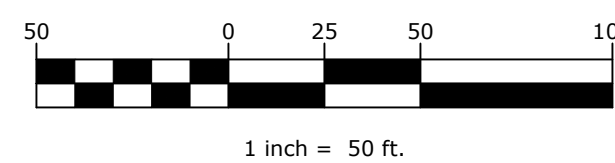SMITH SUBDIVISION
FIRST STREET
TOWN OF MARLBOROUGH
ULSTER COUNTY, NEW YORK

JOB #:	1022.06	DRAWN BY:	BDB
DATE:	08/25/18	SCALE:	1" = 50'
REVISION:	4 - 02/05/19	TAX LOT:	103.1-4-47.13


RS-1

I HEREBY CERTIFY TO THE PARTIES OF INTEREST LISTED BELOW:

DOUGLAS SMITH;
TOWN OF MARLBOROUGH;

THAT THIS SURVEY MAP IS THE RESULT OF AN ACTUAL FIELD SURVEY PERFORMED BY ME OR UNDER MY DIRECT SUPERVISION AND THAT IT IS TRUE AND ACCURATE TO THE BEST OF MY KNOWLEDGE AND BELIEF, BASED ON DATA CONTAINED IN DEEDS OR MAPS OF RECORD LISTED HEREON, TOGETHER WITH EVIDENCE FOUND IN THE FIELD, AND THAT THERE ARE NO SURFACE ENCROACHMENTS EXCEPT AS OTHERWISE SHOWN HEREON, AS COMPLETED ON MARCH 6, 2013.

ONLY BOUNDARY SURVEY MAPS WITH THE SURVEYOR'S
EMBOSSSED SEAL ARE GENUINE TRUE AND CORRECT COPIES OF
THE SURVEYOR'S ORIGINAL WORK AND OPINION.

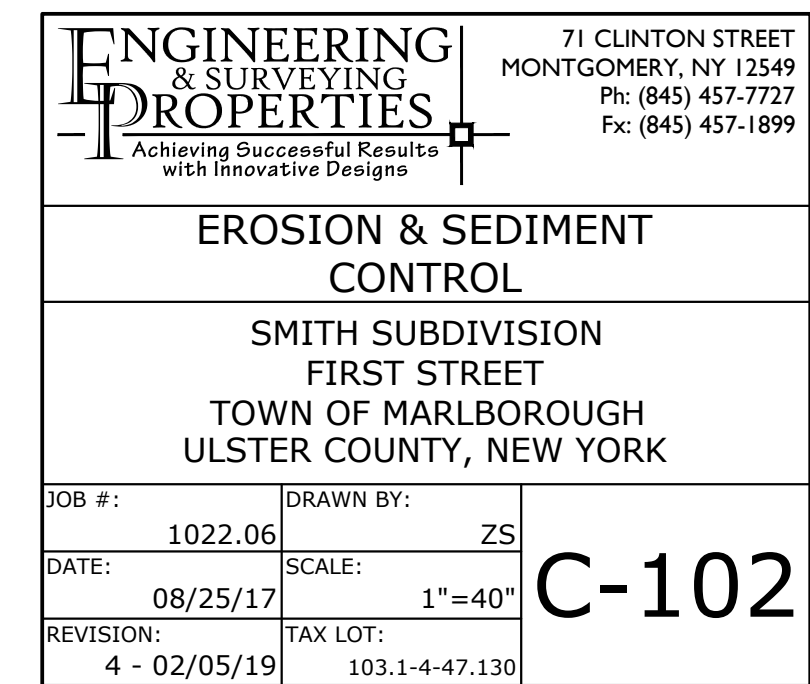

PERCOLATION TEST RESULTS

LOT #	PERC HOLE #	PERC HOLE DEPTH	PERC HOLE DIA	TIME	PERCOLATION TEST RUNS - STOPWATCH USED FOR ALL TESTS (TIME FOR 1" DROP IN WATER LEVEL)						STABILIZED RATE
				FINISH							
1	08/31/17 PT-1	24"	12"	FINISH							7 MIN
				START	STOPWATCH	USED FOR TIMED INTERVALS					
				TIME	00:05:43	00:05:59	00:06:32				
1	08/31/17 PT-2	24"	12"	FINISH							19 MIN
				START	STOPWATCH	USED FOR TIMED INTERVALS					
				TIME	00:17:15	00:18:07	00:18:42				
2	08/30/17 PT-1	24"	12"	FINISH							33 MIN
				START	STOPWATCH	USED FOR TIMED INTERVALS					
				TIME	00:21:06	00:30:48	00:32:25				
2	08/30/17 PT-2	24"	12"	FINISH							30 MIN
				START	STOPWATCH	USED FOR TIMED INTERVALS					
				TIME	00:15:03	00:28:15	00:29:03				
3	08/30/17 PT-1	24"	12"	FINISH							37 MIN
				START	STOPWATCH	USED FOR TIMED INTERVALS					
				TIME	00:22:06	00:29:51	00:37:51	00:36:49			
3	08/30/17 PT-2	24"	12"	FINISH							5 MIN
				START	STOPWATCH	USED FOR TIMED INTERVALS					
				TIME	00:02:58	00:03:36	00:04:18	00:04:30			
4	08/30/17 PT-1	24"	12"	FINISH							11 MIN
				START	STOPWATCH	USED FOR TIMED INTERVALS					
				TIME	00:11:37	00:10:04	00:10:53				
4	08/30/17 PT-2	24"	12"	FINISH							18 MIN
				START	STOPWATCH	USED FOR TIMED INTERVALS					
				TIME	00:10:27	00:11:58	00:13:34	00:14:45	00:17:28	00:17:33	
5	08/30/17 PT-1	24"	12"	FINISH							18 MIN
				START	STOPWATCH	USED FOR TIMED INTERVALS					
				TIME	00:10:40	00:16:25	00:17:18				
5	08/30/17 PT-2	24"	12"	FINISH							30 MIN
				START	STOPWATCH	USED FOR TIMED INTERVALS					
				TIME	00:15:03	00:28:15	00:29:03				

SEPTIC SYSTEM DESIGN SCHEDULE


LOT #	STABILIZE PERC RATE (min)	PROPOSED MAP BEDROOMS	FLOW RATE (GPD)*	APPLICATION RATE (GPD/Sq. ft.)	REQUIRED AREA (Sq. ft.)	REQUIRED ABSORPTION FIELD LENGTH (ft) (BASED UPON 2" WIDE TRENCH)	PROPOSED ABSORPTION FIELD LENGTH (ft)
1	19	4	440	0.70	629	315	7 @ 45 = 315
2	33	4	440	0.50	880	440	10 @ 44 = 440
3	37	4	440	0.50	880	440	10 @ 44 = 440
4	18	4	440	0.70	629	315	7 @ 45 = 315
5	30	4	440	0.60	734	367	8 @ 46 = 368

DEEP TEST HOLE RESULTS

LOT #	TEST HOLE #	DATE	DEPTH	DESCRIPTION
1	JSI TP 1	10/19/18	0'-12" 12'-70"	TOPSOIL SILTY LOAM NO BEDROCK, NO GROUNDWATER, NO MOTTLING
1	JSI TP 2	10/19/18	0'-14" 14'-50" 50'-66"	TOPSOIL SILTY LOAM GRAVELLY SILTY LOAM NO BEDROCK, NO GROUNDWATER, NO MOTTLING
2	JSI TP 1	10/19/18	0'-6" 6'-24" 24'-60"	TOPSOIL SILTY LOAM GRAVELLY SILTY LOAM NO BEDROCK, NO GROUNDWATER, NO MOTTLING
2	JSI TP 2	10/19/18	0'-8" 8'-24" 24'-74"	TOPSOIL SILTY LOAM GRAVELLY SILTY LOAM NO BEDROCK, NO GROUNDWATER, NO MOTTLING
3	JSI TP 1	10/19/18	0'-13" 13'-32" 32'-57"	TOPSOIL SILTY LOAM GRAVELLY SILTY LOAM W/ COBBLE NO BEDROCK, NO GROUNDWATER, NO MOTTLING
3	JSI TP 2	10/19/18	0'-13" 13'-30" 30'-64"	TOPSOIL SILTY LOAM GRAVELLY SILTY LOAM NO BEDROCK, NO GROUNDWATER, NO MOTTLING
4	JSI TP 1	10/19/18	0'-6" 6'-43" 43'-68"	TOPSOIL SILTY LOAM GRAVELLY SILT LOAM W/ COBBLE NO BEDROCK, NO GROUNDWATER, NO MOTTLING
4	JSI TP 2	10/19/18	0'-4" 4'-32" 32'-64"	TOPSOIL SILTY LOAM GRAVELLY SILT LOAM NO BEDROCK, SEEPAGE @ 50', NO MOTTLING
5	JSI TP 1	10/19/18	0'-6" 6'-21" 21'-70"	TOPSOIL SILTY LOAM RIPPABLE SHALE ROCK @ 21', NO GROUNDWATER, NO MOTTLING
5	JSI TP 2	10/19/18	0'-6" 6'-55"	TOPSOIL CLAY LOAM NO BEDROCK, NO GROUNDWATER, NO MOTTLING

[illegible]

DRAWING STATUS		ISSUE DATE:	
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SHEET NUMBER			
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<input checked="" type="checkbox"/> PLANNING BOARD APPROVAL	4	OF	6
<input type="checkbox"/> UCDOH REALTY SUBDIVISION APPROVAL	4	OF	6
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

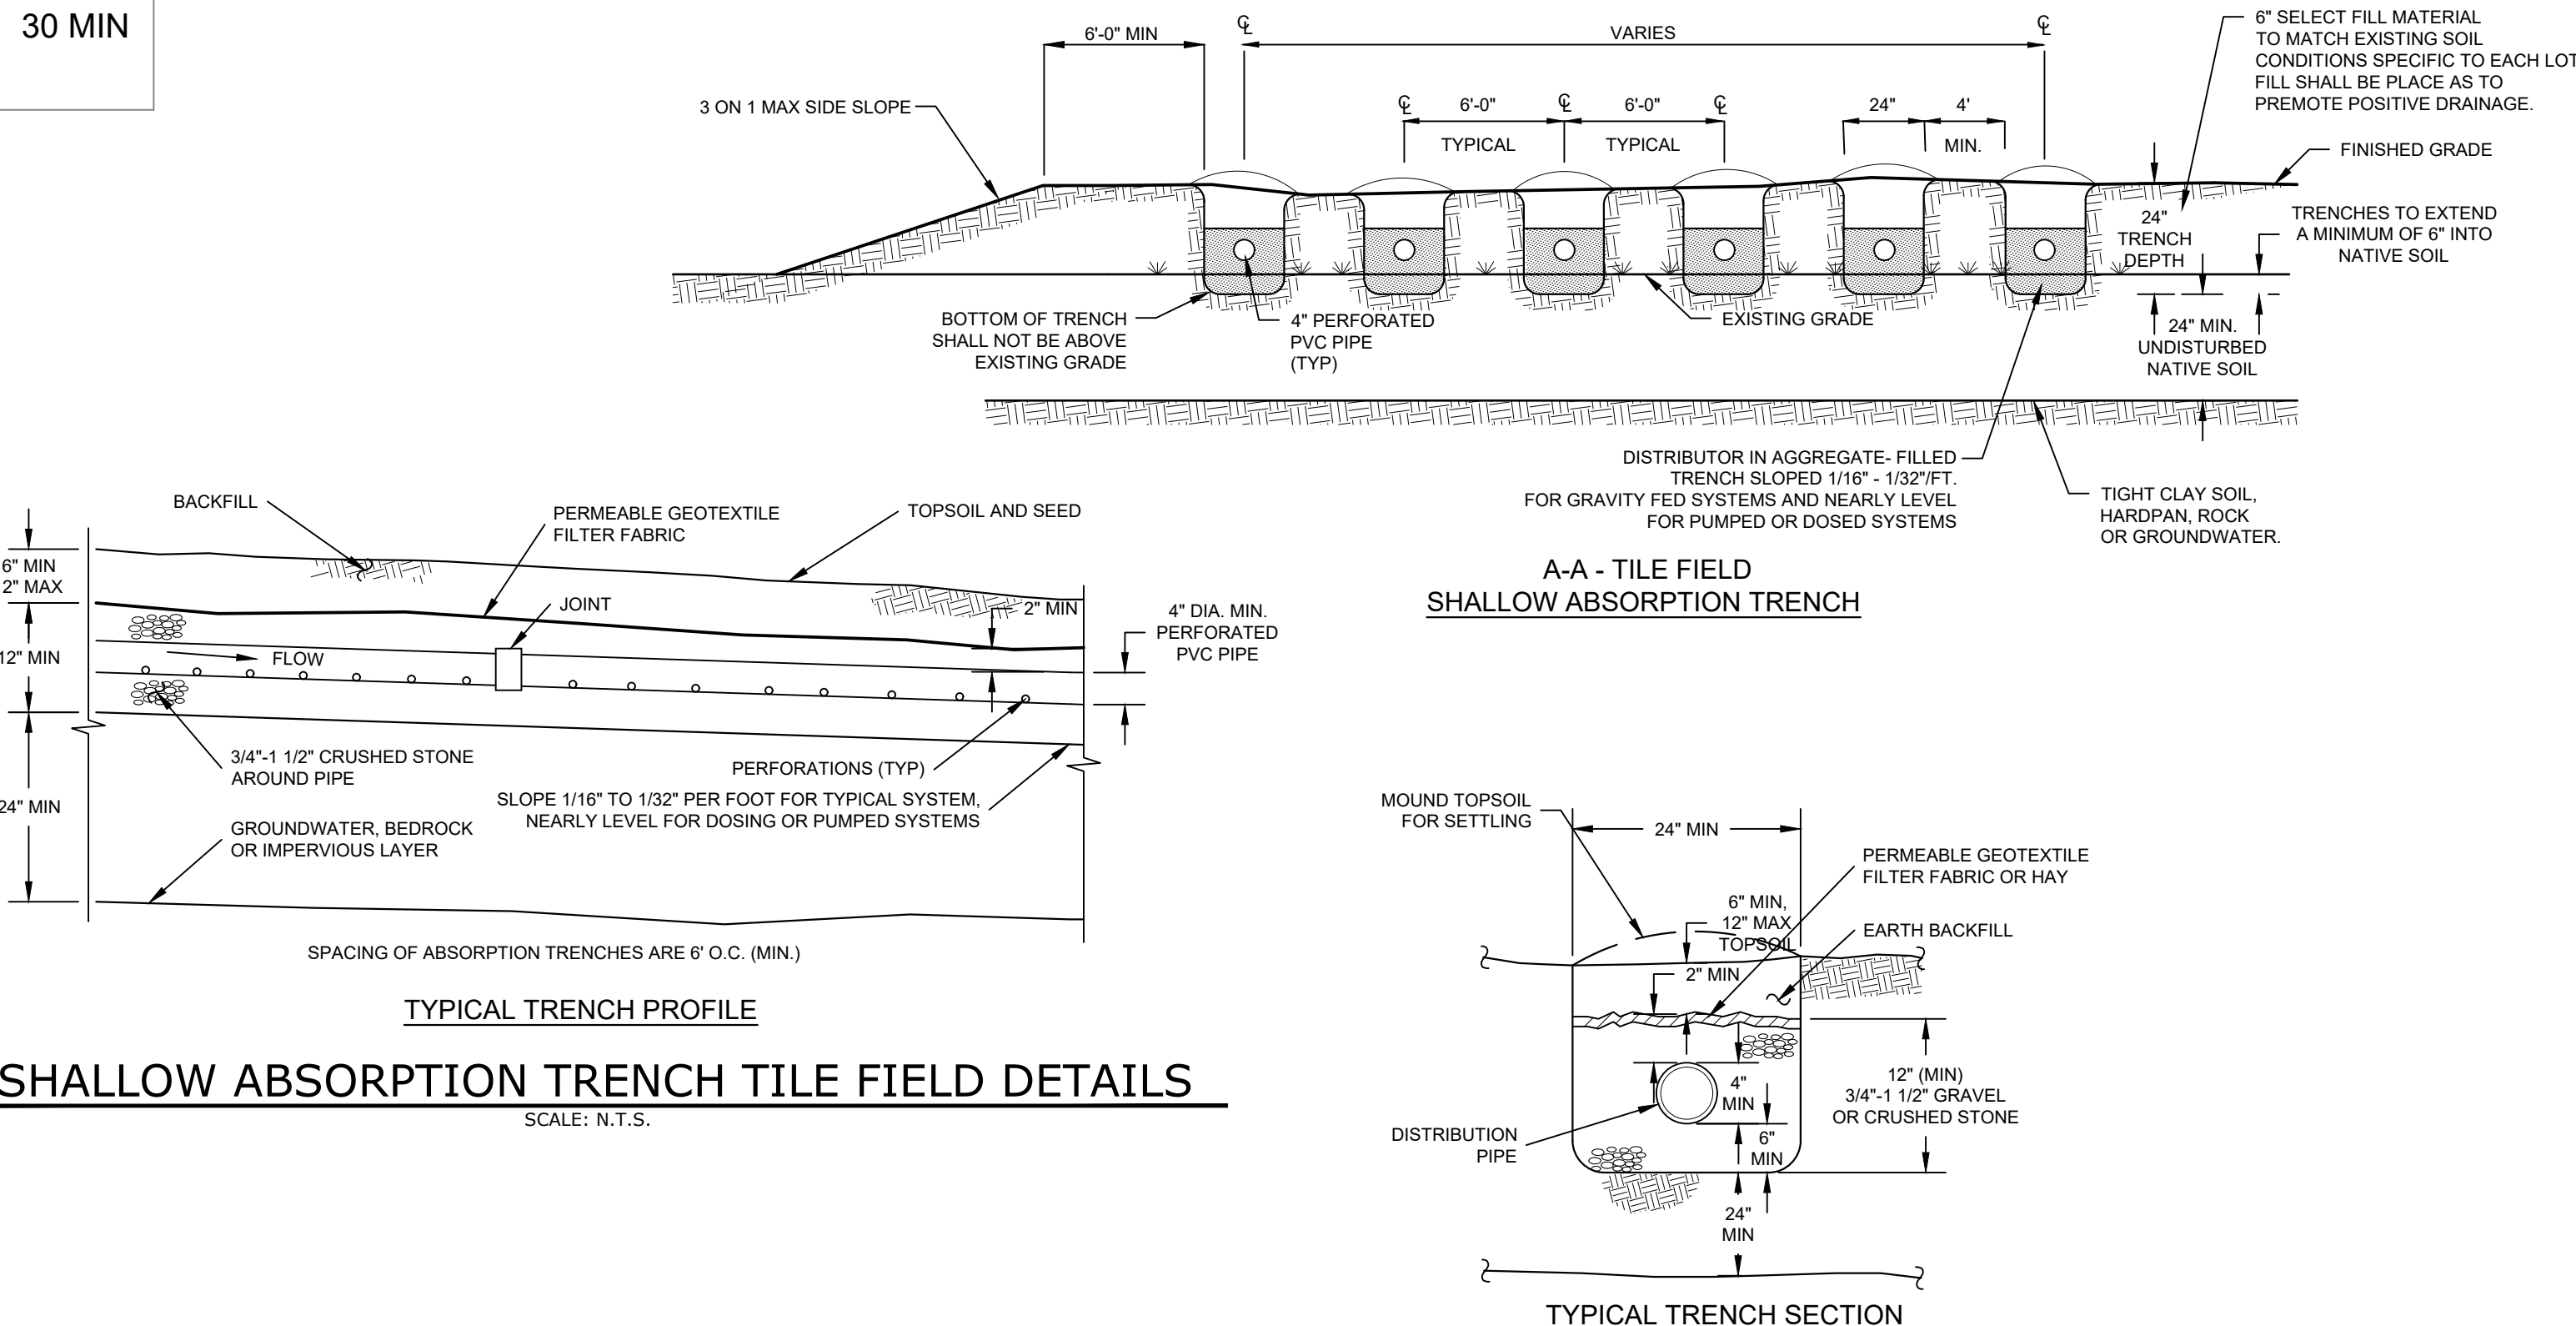
SHALLOW ABSORPTION TILE FIELD OVERALL PLAN

SCALE: NTS


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
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ROSS WINGLOVITZ, P.E.
NEW YORK LICENSE # 071701



A horizontal ruler scale with markings from 0 to 3 inches. The scale is divided into four equal segments, each representing one inch. The markings are as follows: 0 at the left end, 1 at the first division, 2 at the second division, and 3 at the right end. Below the scale is a solid black bar.

ORIGINAL SCALE IN INCHES

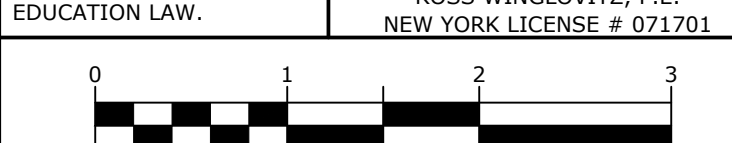

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SOIL TESTING RESULTS & DETAILS

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FIRST STREET
TOWN MARLBOROUGH
ULSTER COUNTY, NEW YORK

JOB #:	1022.06	DRAWN BY:	ZS
DATE:	08/24/17	SCALE:	AS SHOWN
REVISION:	4 - 02/05/19	TAX LOT:	103.1-4-47.130

C-201



- ## ABSORPTION TILE FIELD OVERALL PLAN

SCALE: N.T.S.

NOTES

1. IN ACCORDANCE WITH NYSDEC STORMWATER GREEN INFRASTRUCTURE REQUIREMENTS, ALL ROOF LEADER DOWNSPOUTS SHALL DISCHARGE EFFLUENT ALONG THE SURFACE FOR INFILTRATION.
2. CONNECTION OF ROOF LEADERS TO CLOSED SYSTEMS IS PROHIBITED.
3. HOMEOWNERS SHALL MAINTAIN SPLASH BLOCK LAWN AREA AS SHOWN ON THE PLANS TO PROVIDE INFILTRATION OF STORMWATER.

ROOF LEADER AND SPLASH PAD

SCALE N.T.S.



1. PRECAST CONC. SEPTIC TANK AS MFG. BY WOODARD'S CONCRETE PRODUCTS, INC. MODEL ST 1250, OR APPROVED EQUAL.
2. CONCRETE - 4,000 PSI AT 28 DAYS.
3. REINFORCEMENT - 6" x 6" x 10 GA WIRE MESH.
4. SECTIONS TO BE SEALED WITH BUTYL RUBBER BASE CEMENT.
5. THERE MUST BE AN UNINTERRUPTED POSITIVE SLOPE FROM THE SEPTIC TANK, OR ANY PUMPING OR POSING CHAMBER, TO THE BUILDING, ALLOWING SEPTIC GASES TO DISCHARGE THROUGH THE STACK VENT.
6. SEPTIC TANKS SHOULD BE INSPECTED PERIODICALLY AND PUMPED EVERY 2-3 YEARS.

1250 GAL SEPTIC TANK

SCALE: NTS

1. PRE-CONSTRUCTION: NOTIFY APPROPRIATE MUNICIPAL AND UTILITY OFFICIALS 3-DAYS PRIOR TO START OF CONSTRUCTION
2. FOR DETAILED PHASING REFER TO EROSION CONTROL AND PHASING PLANS.
3. CONSTRUCTION STAGING: STAKE OUT LIMIT OF DISTURBANCE, INSTALL SILT FENCE, STAKE OUT HILL TOPS, STAKE OUT PERMANENT/TEMPORARY STABILIZED CONSTRUCTION ENTRANCE AND STABILIZE CONSTRUCTION ROAD(S). INSTALL TEMPORARY SEDIMENT TRAP(S). INSTALL PERMANENT/TEMPORARY GRASSED AREAS.
4. CLEARING AND GRUBBING: REMOVE VEGETATION FROM AREA OF CONSTRUCTION. STRIP TOPSOIL AND STOCKPILE IN AREAS SHOWN ON THE PLAN. INSTALL SEDIMENT BARRIERS AROUND AND ESTABLISH TEMPORARY PROTECTION ON TOPSOIL STOCKPILE TO PREVENT LOSS OF TOPSOIL.
5. ROUGH GRADING: CUT AND FILL SITE TO APPROXIMATE ELEVATIONS SHOWN ON THE PLAN. IMPLEMENT DUST CONTROL MEASURES AS NECESSARY. ESTABLISH PERMANENT STABILIZATION IN AREAS THAT ARE COMPLETE. ESTABLISH TEMPORARY STABILIZATION IN AREAS THAT WILL BE GRADED AGAIN MORE THAN 14 DAYS FROM LAST DISTURBANCE.
6. ROAD/BUILDING CONSTRUCTION AND UTILITY INSTALLATION: FINAL GRADING AND CONSTRUCTION OF ROADWAYS. BUILDING EXCAVATION AND CONSTRUCTION OF BUILDINGS. INSTALL DRAINAGE INLET AND OUTLET PROTECTION AS EACH INLET/OUTLET IS CONSTRUCTED. ENSURE ALL EROSION CONTROL MEASURES ARE IN WORKING ORDER.
7. FINAL GRADING AND CONSTRUCTION OF PERMANENT/TEMPORARY SEDIMENT TRAPS AND INSTALL PERMANENT WATER QUALITY/QUANTITY FACILITIES. COMPLETE FINE GRADING OF SITE. SPREAD TOPSOIL AND PREPARE FOR PERMANENT PLANTING AND PLANTING. ESTABLISH PERMANENT PLANTING IN ALL REMAINING UNSTABILIZED AREAS. INSTALL ALL SITE LANDSCAPING AND PLANTINGS.
8. POST CONSTRUCTION: UPON STABILIZATION OF THE SITE AND ESTABLISHMENT OF ALL VEGETATION COVER, REMOVE ALL REMAINING TEMPORARY EROSION CONTROL MEASURES PRIOR TO DEPARTURE FROM THE SITE. REMOVE ALL DEBRIS FROM THE SITE INCLUDING ROADWAYS, CATCH BASINS AND STORM DRAINS.



1. WELL IS TO BE CASSED AND GROUTED FOR A MIN OF 50' IN LENGTH.
2. CASING SHALL EXTEND MINIMUM 20" INTO BEDROCK.
3. OVERSIZE DRILL HOLE (FOR GROUTING) TO BE 10" DIAMETER.
4. EXPECTED DEPTH OF LOAM AND SHALE OVERBURDEN = 5 - 30 FEET
5. EXPECTED DEPTH OF WATER BEARING FORMATION = 300 - 600 FEET
6. THE WELL CASING TO CONFORM TO AWWA STANDARD A100 (LATEST EDITION).
7. SANITARY WELL SEAL SHALL BE MONITOR MODEL NO 6WE-1, MFG BY THE BAKER MFG CO; EVANSVILLE, WIS., OR APPROVED EQUAL AND SHALL HAVE THE APPROVAL OF THE WATER SYSTEMS COUNSEL.
8. FITLESS ADAPTOR SHALL BE MONITOR MODEL NO 8PL61U, MFG BY THE BAKER MFG CO; EVANSVILLE, WIS., OR APPROVED EQUAL AND SHALL HAVE THE APPROVAL OF THE WATER SYSTEMS COUNSEL.
9. DISCHARGE PIPE : 1" MIN OF TYPE "K" COPPER WATER LINE
10. WATER SERVICE LINES UNDER PRESSURE SHALL NOT PASS CLOSER THAN 10' OF A SEPTIC TANK, TILE FIELD, OR ANY OTHER PART OF A SEWAGE DISPOSAL SYSTEM.
11. PVC PIPE WITH O-RING JOINTS ARE REQUIRED FOR SEWAGE LINES BETWEEN 25 AND 50 FEET OF ANY WELL.
12. MIN. WELL YIELD TO BE A MINIMUM OF 2 GAL PER MINUTE. ANY WELL PRODUCING BETWEEN 2.5 GPM REQUIRES 24 HOURS OF STORAGE WITHIN HOME.
13. CEMENT GROUT SHALL BE A MIXTURE OF 1 BAG CEMENT (94 LBS) AND 5 1/2 GAL OF CLEAN WATER.
14. ELECTRICAL WORK SHALL BE INSTALLED IN STRICT ACCORDANCE WITH THE REQUIREMENTS OF THE LATEST EDITION OF THE NATIONAL ELECTRICAL CODE.
15. WELL TO BE CONSTRUCTED PER NYSDOH APPENDIX 5-B "STANDARDS FOR WATER WELLS" LATEST EDITION.
16. WELLS ARE TO BE INSTALLED IN THE LOCATIONS SHOWN ON THE PLAN TO ASSURE THE MINIMUM SEPARATION DISTANCES ARE MET.
17. WATER CONTAINING MORE THAN 20 mg/L OF SODIUM SHOULD NOT BE USED FOR DRINKING BY PEOPLE ON SEVERELY RESTRICTED SODIUM DIETS. WATER CONTAINING MORE THAN 270 mg/L OF SODIUM SHOULD NOT BE USED BY PEOPLE ON MODERATELY RESTRICTED SODIUM DIETS.

SCALE: NTS



SECTION A-A

1. DROP BOX AS MANUFACTURED BY WOODARD'S CONCRETE PRODUCTS, INC. CATALOG No. DB-6DB OR APPROVED EQUAL
2. MINIMUM CONCRETE STRENGTH 4,000 PSI AT 28 DAYS
3. CONCRETE TO BE FIBER REINFORCED PER MANUFACTURER'S SPECIFICATION
4. SEAL ALL JOINTS AT INLET/OUTLET PIPES ASPHALTIC MATERIAL OR EQUIVALENT
5. PROVIDE SPEED LEVELERS AT ALL DISTRIBUTION BOX OUTLETS
6. UNUSED OUTLETS TO REMAIN PLUGGED
7. DISTRIBUTION BOXES SHOULD BE INSPECTED PERIODICALLY TO ASSURE THAT THEY ARE LEVEL AND OPERATING PROPERLY.

SCALE: N.T.S.


DRAWING STATUS

ISSUE DATE:
03/05/10

THIS SHEET IS PART OF
THE PLAN SET ISSUED FOR

<input type="checkbox"/> CONCEPT APPROVAL	N/A	OF	N/A
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SMITH SUBDIVISION
FIRST STREET
TOWN MARLBOROUGH
ULSTER COUNTY, NEW YORK

JOB #:	1022.06	DRAWN BY:	ZS	C-301
DATE:	08/25/17	SCALE:	AS SHOWN	
REVISION:	4 - 02/05/19	TAX LOT:	103.1-4-47.130	

